


Proposed Mezzanine Floor Plan

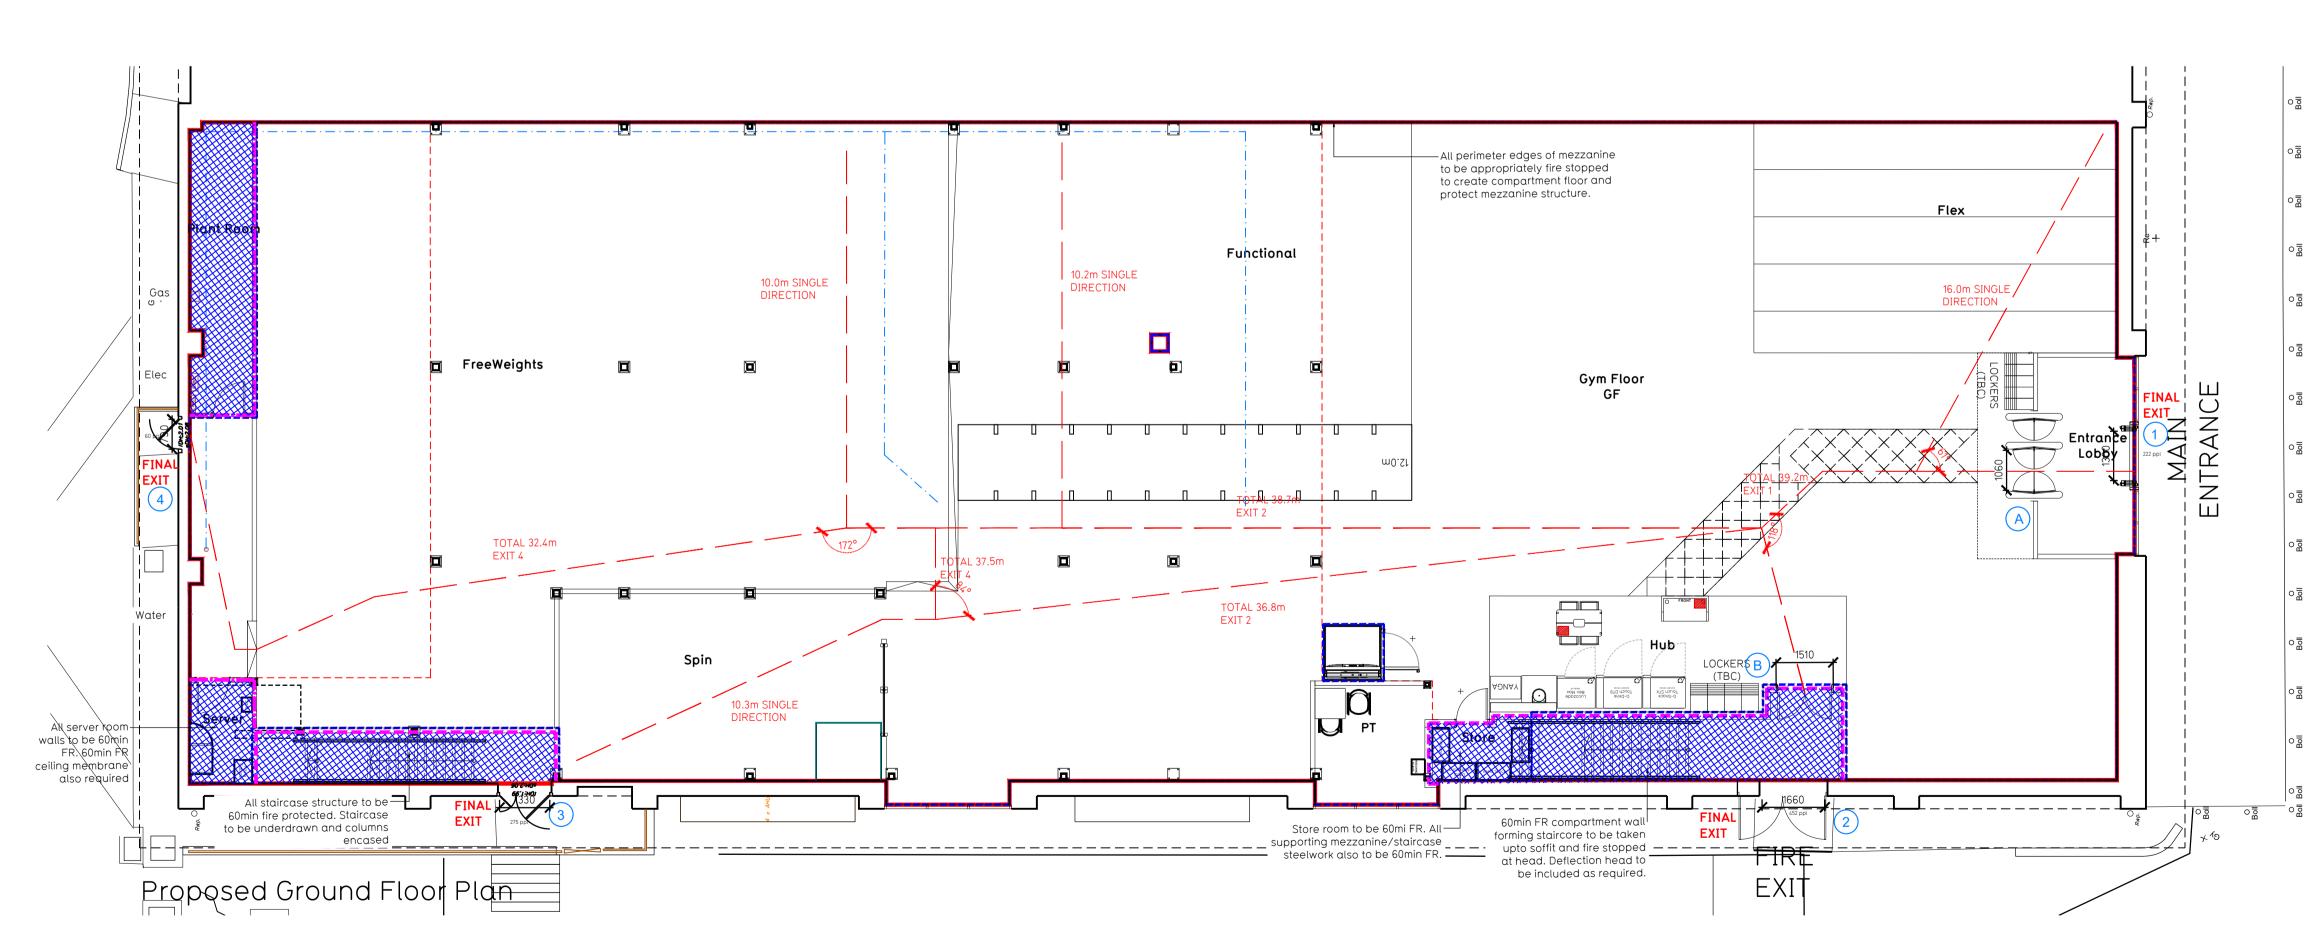

## Fire Evacuation Key

Existing wall to achieve min 30 minute fire rating (suitability of wall to be confirmed on site by Pure Gym Main Contractor	Fire Escape Route	Escape Route Width In line with Sections justification for the			
 Existing wall to achieve min 60 minute fire rating (suitability of wall to be confirmed on site by Pure Gym Main Contractor	<b>1</b> 050 min	Minimum Clear Widths	<u>Ground Floor</u> Final Exit 1 limited b Final Exit 2 limited b		
 New wall to achieve min of 30min fire rating	0	Exit No.	Final Exit 3 Clear Op Final Exit 4 Clear Op Total Aggregate Wi		
 New wall to achieve min of 60min fire rating		Shared Escape Route	<u>Mezzanine Floor</u> Final Exit 2 limited b Final Exit 3 limited b Total Aggregate Wi		
Protected areas: walls, floors, ceilings and doors to achieve 30minute fire resistant construction.					
Protected areas: walls, floors, ceilings and doors to achieve 60 minute fire resistant construction.			Total = 810 persons Based on NIA of 135		

<u>fidths:</u> Ions 3.21 & 3.22 of 'Approved Document Part B, Volume 2 - buildings other than dwellinghouses' - the adjacent calculations provide the clear opening widths for escape from each floor level/ room in accordance with Table 4 & Appendix C.

be included as required.

ited by Storey Exit A Clear Opening Width = 1060mm (allows 222 persons to escape) iited by Storey Exit B Clear Opening Width = 1510mm (allows 312 persons to escape, largest opening to be discounted). ear Opening Width = 1330mm (allows 276 persons to escape) ear Opening Width = 790mm (allows 60 persons to escape) ate Width for Floor (Less Largest Opening Width of 1510mm from Final Exit 2) = 3180mm

te Width for Floor (Less Largest Opening Width = 1608mm (allows 332 persons to escape, largest opening to be discounted) ted by Storey Exit D Clear Opening Width = 1210mm (allows 252 persons to escape) te Width for Floor (Less Largest Opening Width of 1608mm from Final Exit 2) = 1210mm

## 558 persons to escape or = 252 persons to escape sons to escape

f 13519 sqft, the Puregym maxiumum peak occupancy target = 294 persons

Calculated using Puregym Fire Safety Occupancy Levels Forecast Tool.

The designed occupancy of the unit as calculated would allow a max. No. of 810 persons, which is larger than the total estimated occupancy target of 294 persons and is therefore thought to meet with the Approved Document Part B. To allow free movement between the floors the occupancy has not been split 50/50% but rather allows for occupancy based on gym stations and function assuming that a high percentage of the total occupancy could be on a single floor at one time.

<u>Sprinklers</u> System design and installed in compliance with BS EN 12845:2015 & LPC Technical Bulletins

Fire Alarm Fire Alarm Fire Alarm designed and installed to BS 5839. Smoke & heat detection / emergency lighting by specialist. Please refer to M&E engineer's drawings / specifications.

Escape Lighting Emergency escape lighted designed and installed in accordance with BS 5266: Part 1. Please refer to M&E Engineer's drawings for final layout and specification.

Smoke Extract Smoke Extract System to be designed and installed in accordance with BS 7346: Part 8. Please refer to M&E Engineer's drawings for final layout and <del>specification.</del> Escape Signage and emergency lighting is CDP under the M&E specification. Details of contractors proposals to be provided to Building Control Approved Inspector and Fire Officer within the Contractors Proposals Package, Clause 1.4

## NOTE:

- Proposals must comply with all acoustic, fire & building regulation requirements
- No dimensions are to be scaled from this drawing. The contractor is responsible for checking all dimensions on site

C01	31.05.23	r Changing rooms revised to r	new Grid.			SKi/WLT			
C00	28.04.23	Issued for construction				SK/WLT			
Rev	Date	Description				Drawn/ Cl	necked		
PROJECT TITLE DRAWING TITLE   Redditch Relocation Fire Evacuation Plan   Unit XX, Washford Mills, Redditch Ringway, Woucestershire, B98 8DU Ground and Mezzanine Floor Plans									
SK	N / CHECKED (/WT ING PURPOS	19.04.23	SCALE 1:100 @ A1	<b>JOB No</b> 1 2169	DRAWING No 003-FEP	)	Rev		
		RUCTION					C01		
					Pure Gym Ltd Town Centre Hous				

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