


Proposed Ground Floor Plan

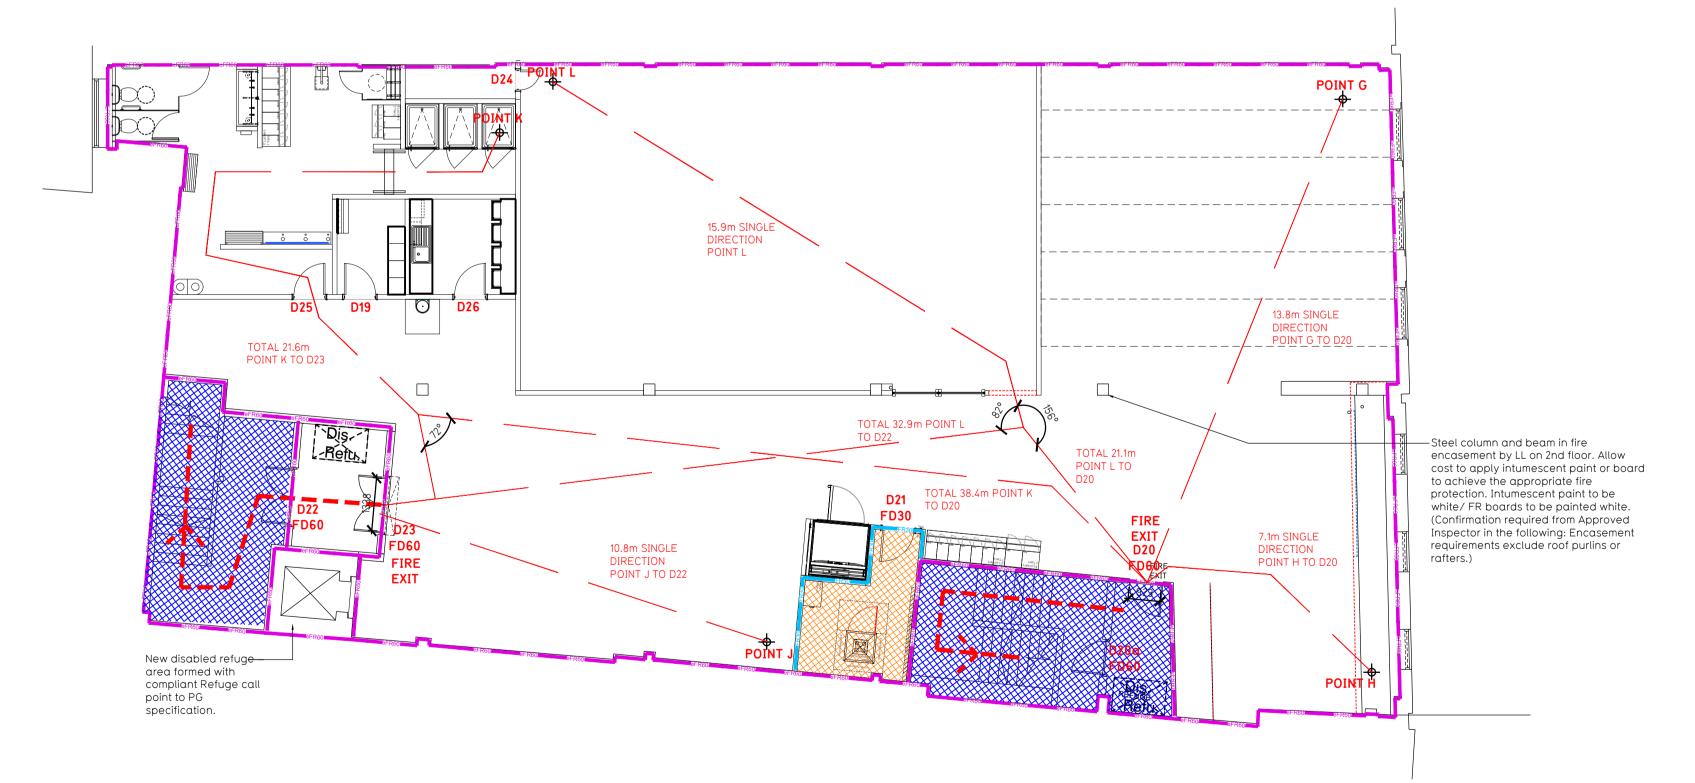

Proposed Second Floor Plan

Fire Evacuation Key

eFR30	Existing wall to achieve min 30 minute fire rating (suitability of wall to be confirmed on site by Pure Gym Main Contractor		———— Fire Escape Route
eFR60	Existing wall to achieve min 60 minute fire rating (suitability of wall to be confirmed on site by Pure Gym Main Contractor	1050 min	Minimum Clear Widths
FR30	New wall to achieve min of 30min fire rating	0	Exit No.
FR60	New wall to achieve min of 60min fire rating		Shared Escape Route
	Protected areas: walls, floors, ceilings and doors to achieve 30minute fire resistant construction.	FDXX	Fire Door Rating
	Protected areas: walls, floors, ceilings and doors to achieve 60 minute fire resistant construction.		

Escape Route Widths:
In line with Sections 3.21 & 3.22 of 'Approved Document Part B, Volume 2 - buildings other than dwellinghouses' - the adjacent calculations provide justification for the clear opening widths for escape from each floor level/ room in accordance with Table 4 & Appendix C.

Ground Floor
Final Fire Exit D1 @ Ground Floor = 1404mm is limited by Intermediate Fire D2 = 1050mm (allows 220 persons to escape).
Final Fire Exit D1 @ Ground Floor = 1404mm is limited by Intermediate Fire D2 = 1050mm (allows 220 persons to escape).
Final Fire Exit D1 @ Ground Floor = 1662mm (allows 342 persons to escape & sized to allow for merged flow from Intermediate Fire Exits @ First Floor (D14) and @ 2nd Floor (D22). At Ground floor this Final Fire Exit is limited by Intermediate Fire Exit D7 = 1356mm (allows 281 persons to escape)

(Largest opening to be discounted)

The designed occupancy of the unit as calculated below would allow a max. No. of 440 persons to escape, which is larger than the total estimated occupancy capacity of 289 Persons and is therefore thought to meet with the Approved Document Part B. To allow free movement between the floors the occupancy has not been split 50/50% but rather allows for occupancy one time.

First Floor
Final Fire Exit D10 1256 @ Ground Floor is limited by Intermediate Fire Exits D11 & D11a @ FF = 923mm (allows 110 persons to escape).
Final Fire Exit D9 1662mm is limited by Intermediate Fire Exit D13 @ FF = 1400mm (allows 290 persons to escape).
(Largest opening to be discounted)

Second Floor
Final Fire Exit D10 1256mm @ Ground Floor is limited by Intermediate Fire Exit D20 = 923mm (allows 110 persons to escape).
Final Fire Exit D9 @ Ground Floor 1662mm is limited by Intermediate Fire Exit D23 = 1338mm (allows 277 persons to escape) is limited (Largest opening to be

Total
Ground = 220 persons to escape
First= 110 persons to escape
Second = 100 persons to escape

Total= 440 persons to escape

Based on a NIA of 12815sqft, the Puregym Peak Peak Occupancy Target = 289 Persons Calculated using Puregym Fire Safety Occupancy Levels Forecast Tool

Fire Alarm
Fire Alarm designed and installed to BS 5839. Smoke & heat detection / emergency lighting by specialist. Please refer to M&E engineer's drawings / specifications.

Escape Lighting
Emergency escape lighted designed and installed in accordance with BS 5266: Part 1. Please refer to M&E Engineer's drawings for final layout and specification.

Escape Signage and emergency lighting is CDP under the M&E specification. Details of contractors proposals to be provided to Building Control Approved Inspector and Fire Officer within the Contractors Proposals Package, Clause 1.4

C01	14.02.24	Updated as per 001-GA					MI/HB	
Rev	Date	Description		DRAWING TITLE			Drawn/	Checked
DRAW		don, The Broadwa 27 The Broadway, Londor	y 5 SW19 1PS		cuation Plar		Dlana	
	II/SK/WL	D DATE T 05.12.23	SCALE 1:100 @ A		JOB No 2195	econd Floor DRAWING I 003-FEF	No	_
DRAWI	II/SK/WL NG PURPOS	D DATE T 05.12.23	SCALE		JOB No	DRAWING I	No	Rev C01
DRAWI	II/SK/WL NG PURPOS	D DATE T 05.12.23	SCALE		JOB No 2195	DRAWING I	No D	